

PROPOSED MULTI UNITS


at

22-26 ARTHUR ST WOODY POINT QLD

for

KARAM BOUTIQUE RESIDENTIAL 2

PTY LTD

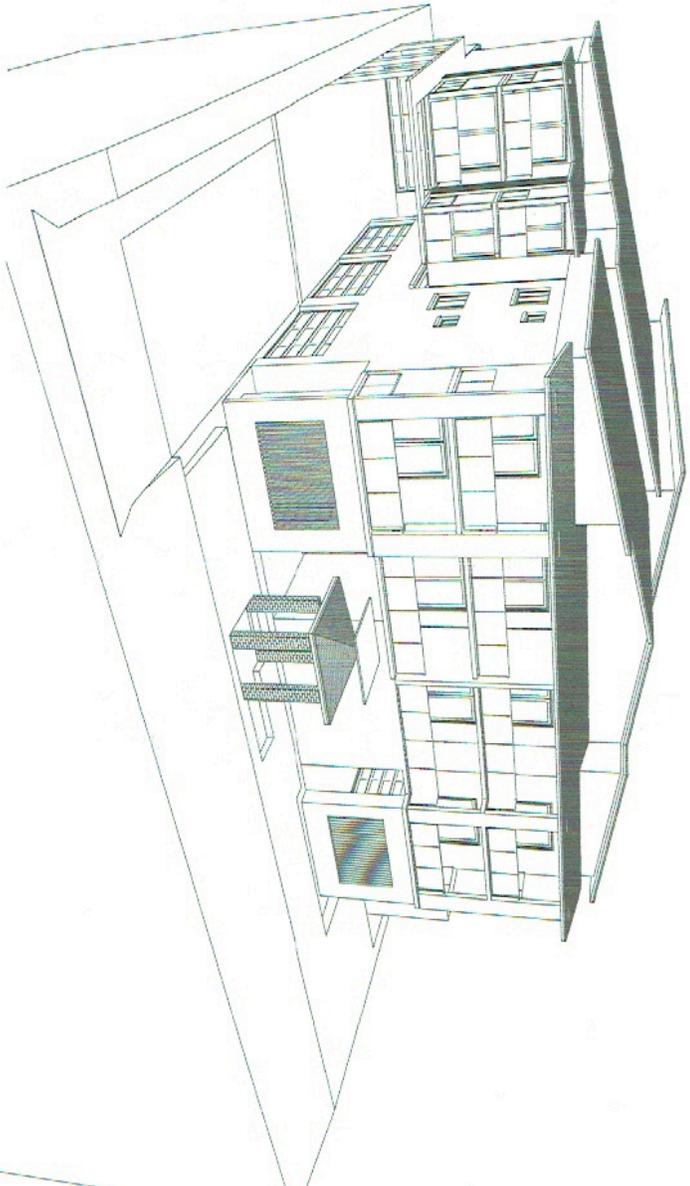

VIEW FROM ARTHUR STREET
NOT TO SCALE

BGA
CLASS XXX MULTI UNITS
WIND CLASSIFICATION, WXXX

APPROVALS
CLASS XXX
DATE 19/02/2018

LOCAL AUTHORITY
MORETON BAY REGIONAL COUNCIL

SOIL CLASSIFICATION
REPORT NO. XXX
CLASSIFICATION CLASS X

STRUCTURAL ENGINEERING
CRITCHTON ENGINEERING

HYDRAULIC ENGINEERING
CHILTON WOODWARD AND ASSOCIATES

ENERGY EFFICIENCY
REPORT NO. (TBA)

ENERGY RATING CONSULTANTS

BUILDING CERTIFICATION
BUILDING CERTIFICATION CONSULTANTS

WORKPLACE HEALTH & SAFETY
APPENDIX 1

NO	DESCRIPTION	REV
01	COVER PAGE	01
02	ELEVATION 1 (R/W)	01
03	SECTION 1 (R/W)	01
04	SECTION 2 (R/W)	01
05	SECTION 3 (R/W)	01
06	SECTION 4 (R/W)	01
07	SECTION 5 (R/W)	01
08	ELEVATION 2 (R/W)	01
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102	SECTION 99 (R/W)	01
103	SECTION 100 (R/W)	01

BUILDING APPLICATION
This form is for the Building Application process. It is to be completed by the applicant and submitted to the Council. The Council will then issue a Building Application Number (BAN) and a Building Application Fee. The Council will then issue a Building Application Certificate (BAC) and a Building Application Certificate of Compliance (BACC). The Council will then issue a Building Application Certificate of Occupancy (BACO) and a Building Application Certificate of Completion (BACC).


SK Drafting
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Email: info@skdrafting.com.au

KARAM BOUTIQUE
RESIDENTIAL 2 PTY LTD
PROPOSED MULTI UNITS
22-26 ARTHUR ST WOODY
POINT QLD

Drawn By: [Name]
Checked By: [Name]
Scale: AS 1600
Project No: 19-055
Drawing No: W001

Project No: 19-055
Drawing No: W001
Date: 17/02/18

BUILDING APPLICATION
 This plan is for building application for a proposed residential building. The applicant is responsible for providing all necessary information and documentation to support the application. The Council will consider the application in accordance with the relevant provisions of the Resource Management Act 1991 and the Resource Management Act Regulations 2002. The Council may require the applicant to provide further information or to undertake further work before a decision is made on the application.

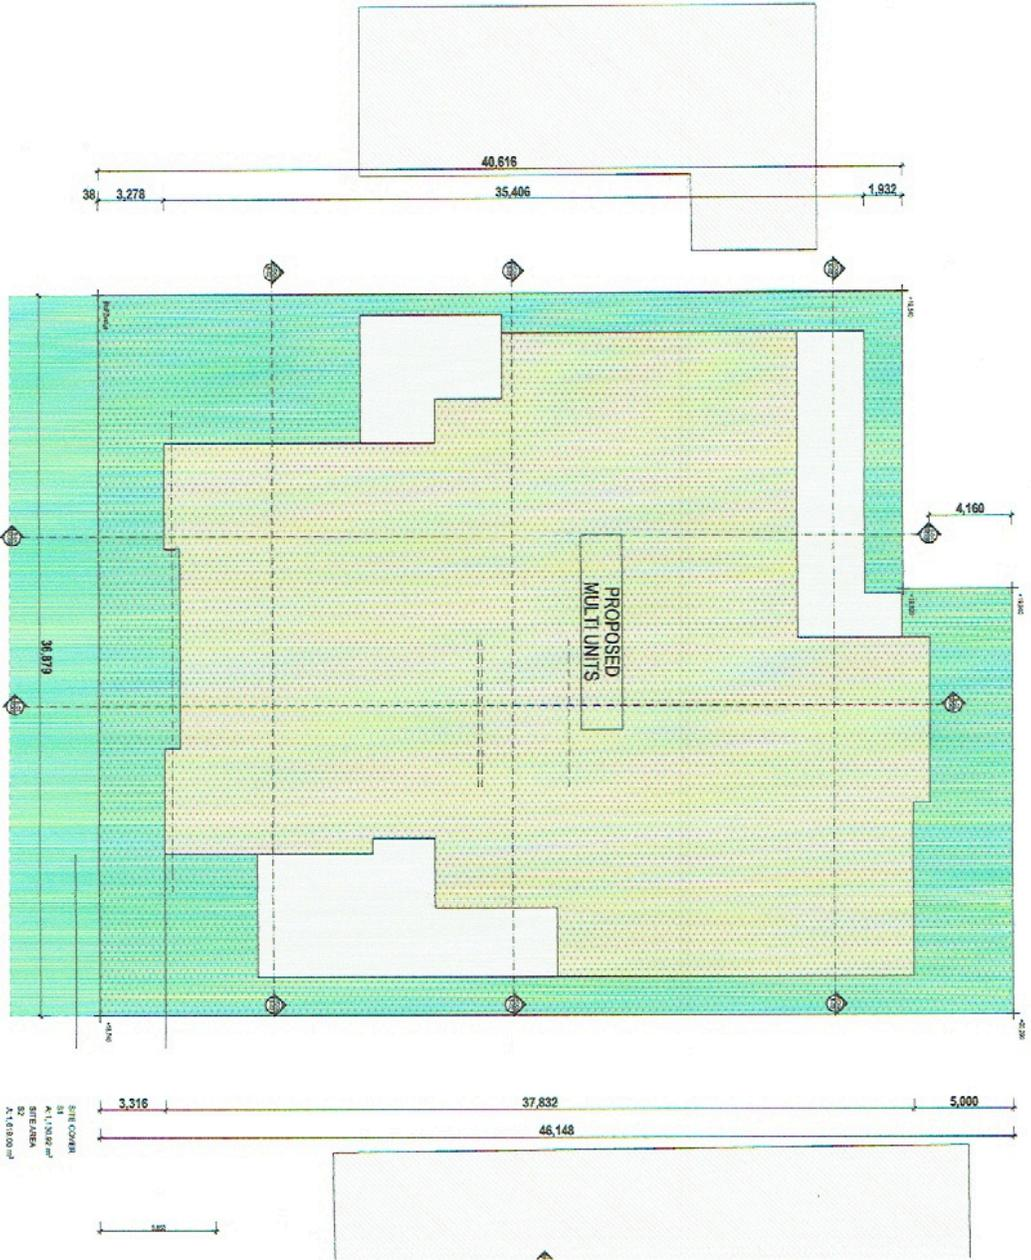

SITE PLAN
 SCALE 1 : 125

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RECD
 LOT 1 RP77263
 18 RENNE STREET
 REDDIFRUE QLD 4020
 SITE AREA 759M²

SEA
 GROUND 301.55M²
 LEVEL 1 368.21 M²
 LEVEL 2 368.21 M²
 LEVEL 3 368.21 M²
 TOTAL GFA 1400.18M²

Client
 KARAM BOUTIQUE
 RESIDENTIAL 2 PTY LTD

Project Name
 PROPOSED MULTI UNITS
 22-26 ARTHUR ST WOODY
 POINT QLD

Site Corner
 SE 11.1082 m²
 SW 11.1082 m²
 NE 11.1082 m²
 NW 11.1082 m²

Site Area
 759.00 m²

Overall Area
 1400.18 m²

SK Drafting
 building designs

Created By
 A. L. S. 10/20/20

Checked By
 A. L. S. 10/20/20

Scale
 1:125

Project No.
 19-055

Drawing No.
 WPD03

BUILDING PLANS
PROPOSED SITE PLAN

Scale
 1:125


Project No.
 19-055

Drawing No.
 WPD03


GENERAL NOTES

- 1 All building work shall be carried out in accordance with the building code of Australia.
- 2 Provide either:
A fire rated ceiling with resistance to the incident speed of fire of 1 hour with 2 layers of the rated distribution fixed in accordance with the manufacturers specifications.
Or alternatively provide a non fire rated ceiling to the upper floor, with the floor common ceiling walls between walls, stairwell, lift and foyer to continue vertically to the underside of a non combustible roof. Concrete pipes with backwood. No minor roof framing to protrude between ceiling party walls.
- 3 All pipes penetrating concrete floors shall be fitted with approved fire collars.
- 4 Entry doors self closers and floor handles to all units shall be fire rated 120/30.
- 5 Lever handles to be bonded at 1000 to 1100 above finished floor level.
- 6 Lifts to be fitted with -50° fire doors.
- 7 Ensure lift core panel is bonded 500mm out from any internal corner with signage Warning - do not use in fire event)
- 8 Doors passing thru walls to have FRL -120/30
- 9 Physiological smoke alarms to be hard wired and bonded in all levels of common areas and to activate building occupant warning system providing 60 dB(A) min at SCU entry doors marked on plan as SD.
- 10 Also provide hard wired fire/smoke detector in each bedroom study and living area of each unit.
- 11 Provide 1 fire rated smoke detector interconnected with all other common smoke detectors at top of lift shaft with re-chargeable 10 year life battery.
- 12 Provide emergency lighting and exit signs at garage level and at each unit level as marked at EL and exit on plans.
- 13 Provide non slip mats to external and common areas and use the at bottom of stairs and at each landing.
- 14 Provide a clothes dryer for each unit as alternative to clothes lines.
- 15 The separating walls between SCUs and SCUs and any plant room, stairway, public lobby, public corridor and the lift have HW & CR (gabion) not less than 50 and be of discontinuous construction if wall separates bathroom, sanitary compartment, laundry or kitchen from a habitable room in an adjoining unit other than a kitchen or an SCU from a plant room or lift shaft.
Where doors, wall, window or window supply pipes (including ducts or pipes located in approved cartrage) serve a plant room, the HW & CR (gabion) must be separated from the rooms of adjoining units by a wall of HW & CR (gabion) not less than 40 for the adjacent room is a habitable room other than a bathroom or 50 if the adjacent room is a kitchen or a non-habitable room.
- 16 Fire and sound separating walls and floors to be inspected by Approved Competent Person. Certificate is required from DECC Licensed Contractor with appropriate PT license.
- 17 Floors in class 2 buildings must have Fw & Cr (gabion) not less than 50 and Low not more than 62 if it separates SCUs or SCUs from a plant room, lift shaft, stairways, public lobby, public corridor and the lift, or parts of a different classification.
- 18 Lift shafts to have fire rated (d over -FRL-120/30)
- 19 Provide 30% luminance contrast to signage or acceptable public at least in accordance with AS/NZS 13009 (Clause 13 with 650mm clear width (800 mm door size) and 1100mm minimum 900-1100mm above FRL.
- 20 Refer D16 and Specification 004 for additional signage required at all doorways provided with an illuminated exit sign - signage to be colour contrasting and in braille where that door is an exit door and which serve the occupant is located on.
- 21 Any full height glazing that could be mistaken for an opening in common areas shall have colour contrasting red, 50 to 150mm high bottom edge located 800-1000mm above FRL.

ROOF PLAN
SCALE 1 : 100

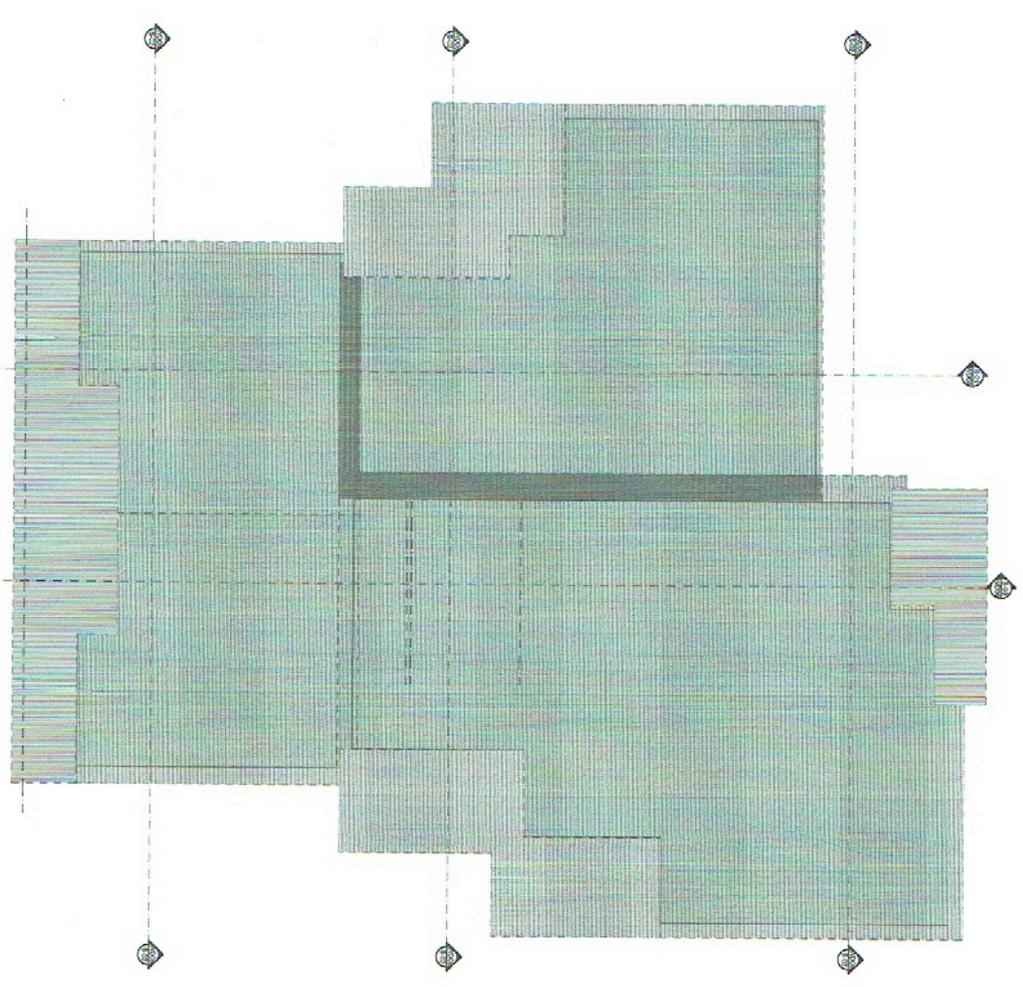

BUILDING APPLICATION
Please refer to the Building Application Form for more information. The Building Application Form is available on the Council's website. The Building Application Form is available on the Council's website. The Building Application Form is available on the Council's website.

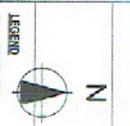

LEGEND

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Email: info@skdrafting.com.au
www.skdrafting.com.au

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CONTRACT
BUILDING PLANS
ROOF PLAN

CLIENT
KAYAM BOUTIQUE
RESIDENTIAL 2 PTY LTD
PROPOSED MULTI UNITS
22-28 ARTHUR ST WOODY
POINT QLD


SCALE
SCALE: 1:100

DATE
19-05-2024

PROJECT NO.
WDD07



SECTION S-01
SCALE 1 : 100

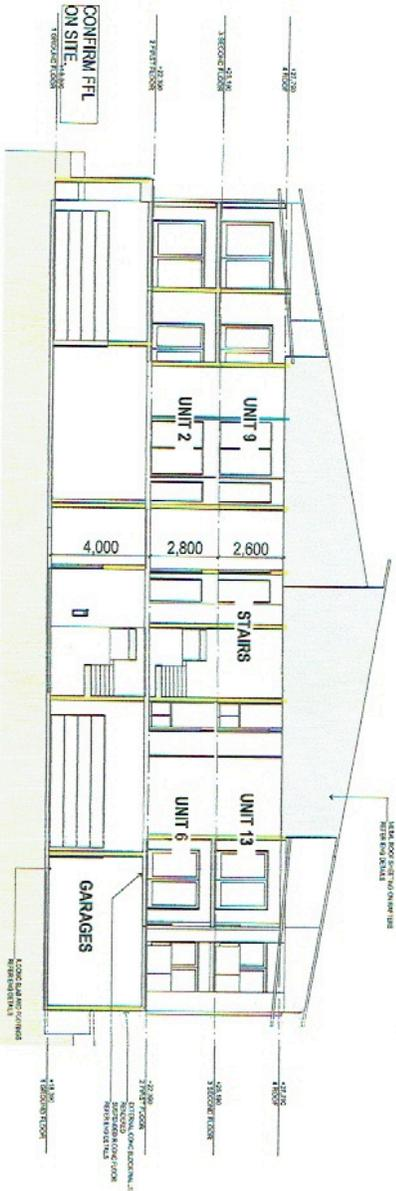

SECTION S-02
SCALE 1 : 100

BUILDING APPLICATION
This drawing is for the use of the Building Department only. It is not to be used for any other purpose. The Building Department is not responsible for the accuracy of the information provided in this drawing. The Building Department is not responsible for the accuracy of the information provided in this drawing. The Building Department is not responsible for the accuracy of the information provided in this drawing.

SX Drafting
Building Design
1000 14th Street, N.W.
Atlanta, GA 30309
404.525.1111
www.sxdrafting.com

Project Name: PROPOSED MULTI UNITS
22-26 ARTHUR ST WOOD
POINT QLD

Client: KARAM BOUTLE
RESIDENTIAL 2 PTY LTD

Scale: AS SHOWN

Project No: 19-055
Drawing No: YD008

Date: 27/09/2019

